
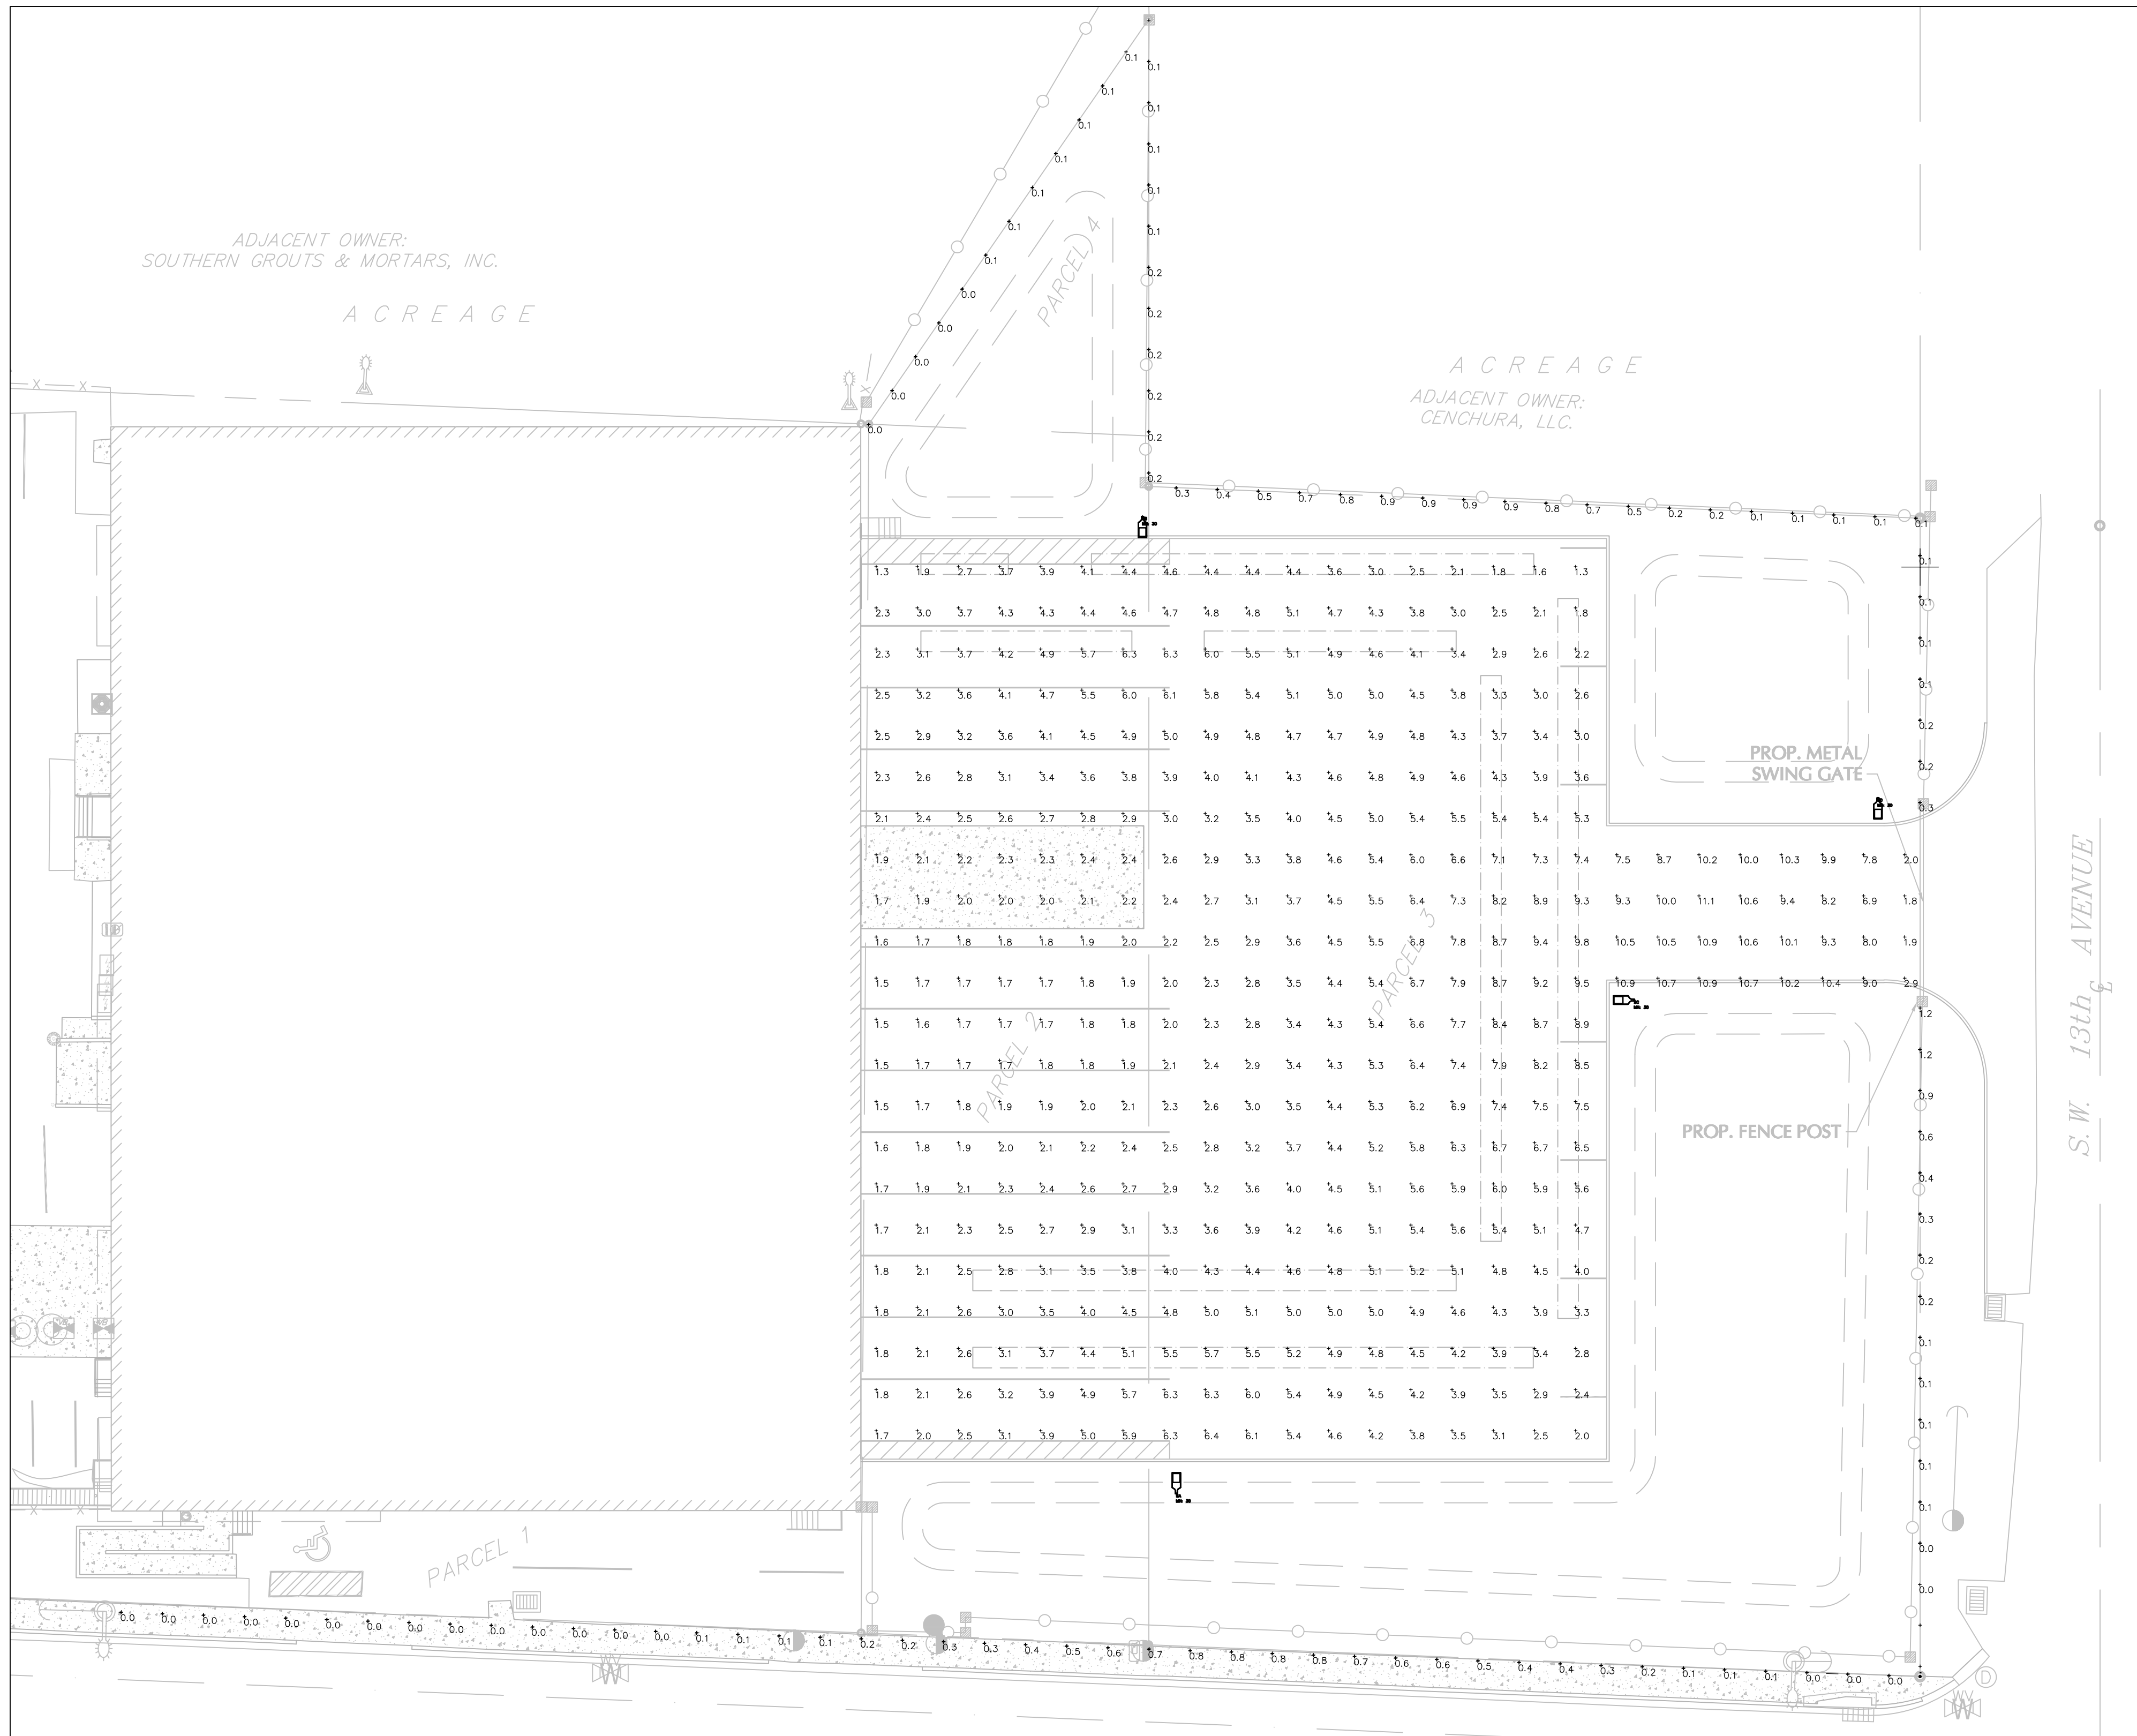


DRC



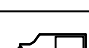
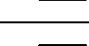
PZ23-12000018
09/06/2023

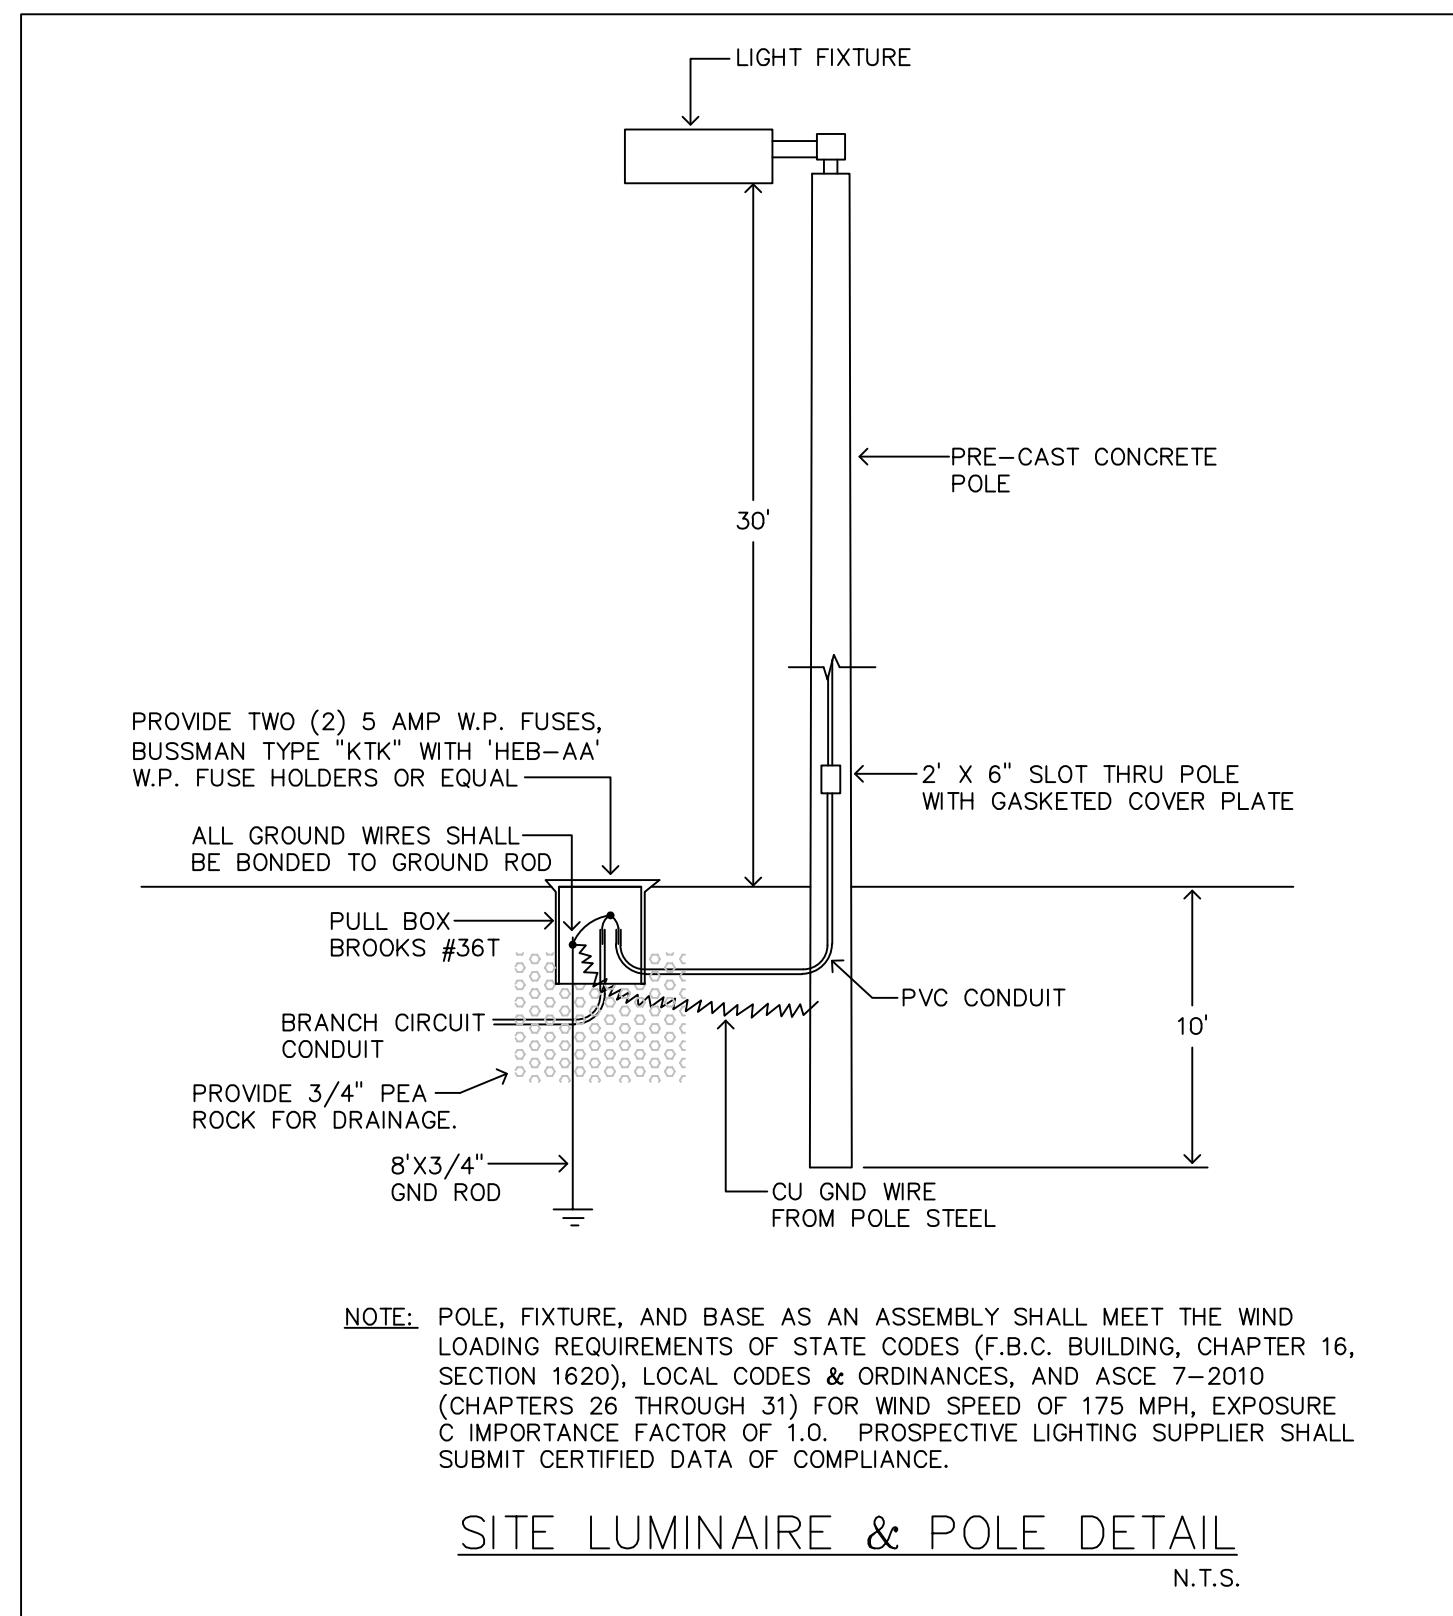


PHOTOMETRIC SITE PLAN

SCALE:

1" = 20'-0"

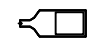
LUMINAIRE SCHEDULE									
SYMBOL	QTY	LABEL	ARRANGEMENT	MANUFACTURER	CATALOG NUMBER	MOUNTING	EMERGENCY	LLF	LUMINAIRE LUMENS
	1	SA	Single	Lithonia Lighting	DSX2 LED PS 40K 70CRI TFTM HS	POLE MOUNTED: 25' A.F.G.	N/A	0.900	48258
	1	SB	Single	Lithonia Lighting	DSX2 LED PS 40K 70CRI BLC4	POLE MOUNTED: 25' A.F.G.	N/A	0.900	42296
	1	SC	Single	Lithonia Lighting	DSX2 LED PS 40K 70CRI T3M	POLE MOUNTED: 25' A.F.G.	N/A	0.900	56309
	1	SD	Single	Lithonia Lighting	DSX2 LED PS 40K 70CRI LCCO	POLE MOUNTED: 20' A.F.G.	N/A	0.900	41334
LUMINAIRE WATTS									

CALCULATION SUMMARY										
LABEL	CALC TYPE	UNITS	SPACING L-R (FT)	SPACING T-B (FT)	HEIGHT (FT)	AVG	MAX	MIN	AVG/MIN	MAX/MIN
PARKING & DRIVEWAY	Illuminance	Fc	8	8	0	4.33	11.1	1.3	3.33	8.54
PROP. LINE	Illuminance	Fc	8	N.A.	N.A.	0.26	1.2	0.0	N.A.	N.A.

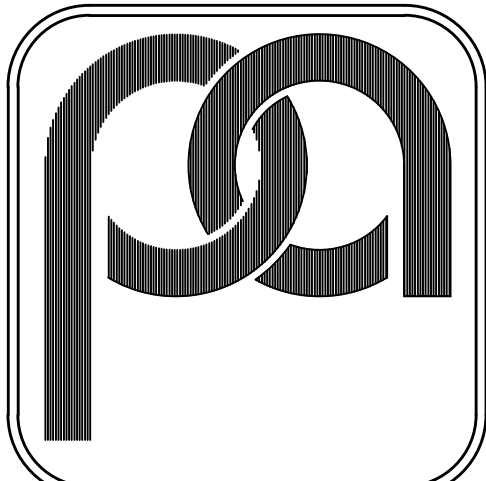

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7326 S.W. 48th Street
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(305) 661-7700

SEAL :

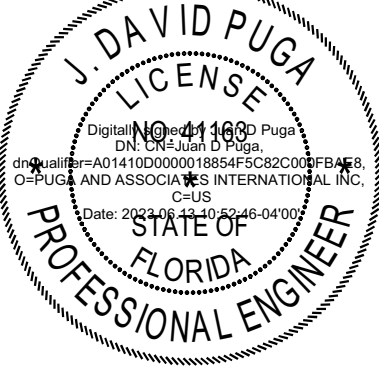

BLP-POMPANO BEACH
SITE LIGHTING PHOTOMETRIC STUDY
290 SW 14 AVENUE,
POMPANO BEACH FLORIDA 33069

REV	DATE

DRAWN BY: PJG
CHECKED BY: JDP
SCALE: AS NOTED
DATE: 06/13/2023

PROJECT No. 23-504

DRAWING No. 1

ESP-1

DRC
PZ23-12000018
07/19/2023